City of Sacramento Active Transportation Commission Report

915 I Street Sacramento, CA 95814 www.cityofsacramento.org

File ID: 2025-01629 9/18/2025

9th St Separated Bikeway (T15245200)

File ID: 2025-01629

Location: 9th Street from Q Street to Broadway; District 4

Recommendation: Review and comment.

Contact: James Kragh, Associate Civil Engineer, (916) 808-6842, jmkragh@cityofsacramento.org,

Department of Public Works

Presenter: James Kragh, Associate Civil Engineer, (916) 808-6842, jmkragh@cityofsacramento.org,

Department of Public Works

Attachments:

- 1-Description/Analysis
- 2-Figures
- 3-Presentation

Description/Analysis

Issue Detail: The 9th Street Separated Bikeway Project (T15245200) will construct a separated southbound bike lane on 9th Street from Q Street to Broadway. It is a key component of the Central City Mobility Project and will complete a bike lane couplet with the existing northbound separated bike lane on 10th Street from I Street to Broadway. 9th Street Separated Bikeway Project, coupled with the 10th Street Separated Bikeway, establishes a clear route to and from the Central City and commercial corridors like Broadway and R Street.

The 9th Street Separated Bikeway project will increase the ability for people biking to access restaurants, parks, medical facilities, and schools. Separated bikeways reduce conflict areas making for a low stress route where riders of all ages and abilities can feel comfortable. This Class IV facility will be an important element to increase connectivity to local assets and advance mobility justice efforts.

The City was awarded funding through the regional Active Transportation Program to deliver the 9th Street Separated Bikeway Project (T15245200) all the way through construction. This project is currently in the preliminary engineering and environmental clearance phase. At this stage, city staff

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are finalizing the project's scope and documenting its potential environmental impacts to ensure regulatory compliance before moving into final design and construction.

While the designs for the 9th Street facility are still in the conceptual stage, staff is seeking feedback on the preliminary design, shown in attachment figures. Additionally, staff is more specifically seeking feedback on the continuation of the separated facility on the left side of the street. This alignment was initially selected to maintain a consistent alignment with the current facility on 9th Street and to avoid conflict with transit operations along the corridor.

Policy Considerations: The actions requested herein are consistent with the Sacramento 2040 General Plan goals and key policies that accommodate and promote safe and convenient travel for all users. The project will enhance healthy transportation system options with active transportation infrastructure (M-1.3), increase walking and biking activity (M-1.11), improve multi-modal access to activity centers such as schools and parks (M1.17), and improve the safety of pedestrians and people bicycling at intersections and crossings (M-1.18).

Economic Impacts: Not applicable.

Environmental Considerations: The current phase of the project includes environmental review to satisfy California Environmental Quality Act (CEQA) requirements.

Sustainability: The project is consistent with the City's General Plan goals to promote walking and bicycling and reduce reliance on automobiles, and to create a healthier urban environment by eliminating barriers for non-motorists with the construction of safe active transportation facilities.

Commission/Committee Action: Receive and comment

Rationale for Recommendation: Preliminary engineering and environmental documentation is expected to be completed by the end of 2025. Community and commission feedback is an important part in formalizing the scope of the project before further design.


Financial Considerations: Not applicable.


Local Business Enterprise (LBE): Not applicable.

9TH ST SEPARATED BIKEWAY PROJECT

OF SACRAMENTO, CALIFORNIA




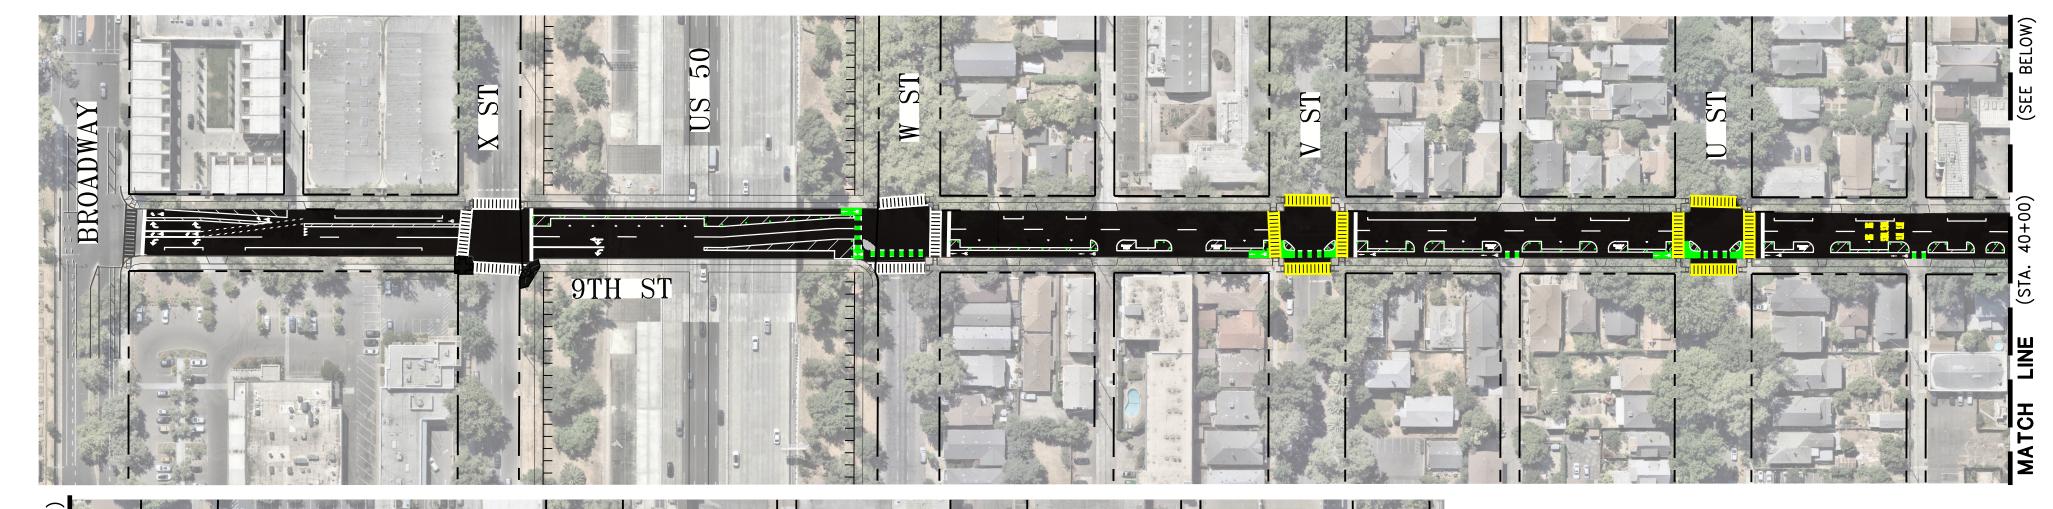

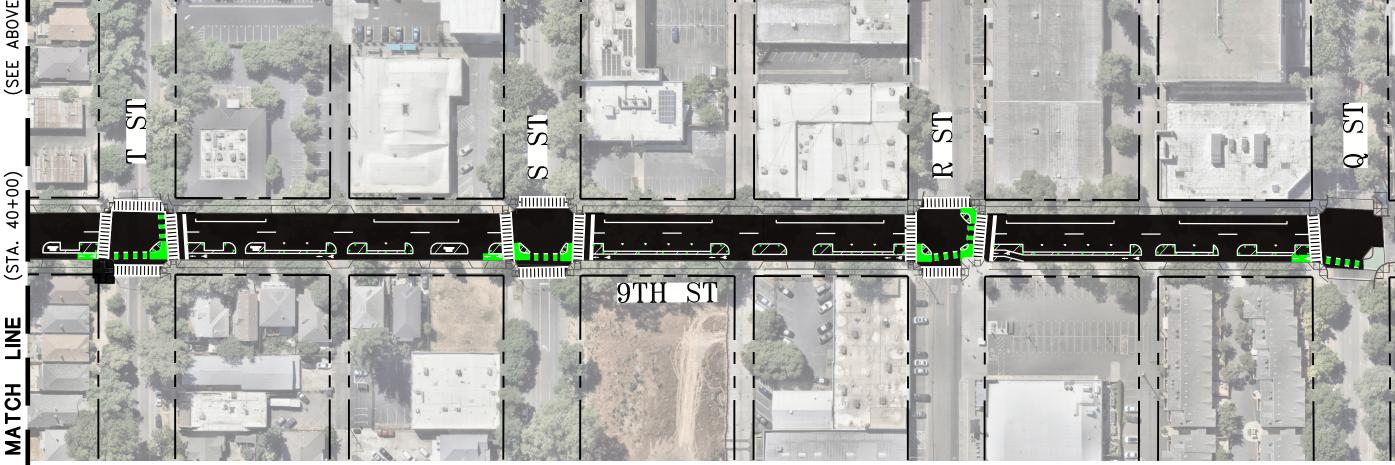

SITE PLAN



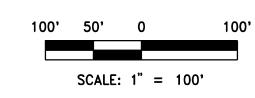

| UTILITY REPRESENTATIVES | | | | | | |
|-------------------------|-------------------------|----------------|----------------|--|--|--|
| UTILITY | COMPANY & | CONTACT | PHONE | | | |
| GAS | P.G. & E. | YVONNE CHATMAN | (916) 386-5453 | | | |
| ELECTRIC | S.M.U.D. | JOE THOMPSON | (916) 732-6986 | | | |
| TELEPHONE | A.T. & T. | ELENA BANKE | (916) 484-2389 | | | |
| WATER | CITY OF SACRAMENTO | JESUS REYES | (916) 808-1721 | | | |
| SEWER | CITY OF SACRAMENTO | JESUS REYES | (916) 808-1721 | | | |
| DRAINAGE | CITY OF SACRAMENTO | JESUS REYES | (916) 808-1721 | | | |
| CATV | COMCAST | MARK DUBY | (916) 830-6743 | | | |
| FIRE | CITY OF SACRAMENTO FIRE | GREG LEDESMA | (916) 808-5936 | | | |
| U.S.A. | | | 1-800-227-2600 | | | |


| S | HEE | PROJECT BOUNDARY SACRAMENTO INDEX |
|---|------|------------------------------------|
| 1 | TS-1 | TITLE SHEET |
| 2 | SD-1 | CONCEPTUAL CROSS SECTION |
| 3 | ST-1 | SIGNING & STRIPING PLAN |
| 4 | ST-2 | SIGNING & STRIPING PLAN |
| | | |

LOCATION MAP

| JUDITH S. MATSUI-DURY, R.C.E. R59096 SUPERVISING ENGINEER | DATE |
|---|------|
| DEPARTMENT OF PUBLIC WORKS | |
| APPROVED BY: | |
| | |
| | |
| JOHN MATOBA, P.E. E-16605 | DATE |
| SENIOR ENGINÉER, ENGINEERING SERVICES DEPARTMENT OF PUBLIC WORKS (ELECTRICAL DESIGN) | |
| APPROVED BY: | |

APPROVED BY:

MEGAN CARTER, R.C.E. 75885
CITY TRAFFIC ENGINEER
DEPARTMENT OF PUBLIC WORKS (SIGNING AND STRIPING)

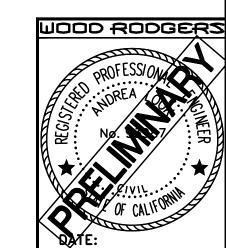

ENGINEER


WOOD RODGERS
3301 C STREET, SUITE 100B
SACRAMENTO, CA 95816
PHONE: (916) 341-7760

30% CONCEPT PLANS

| PHONE: | (910) 341-7700 | | | | | | | | | |
|--------|-----------------------|------|----|-----------------------|----------------------|---|---|-----------|-------------------------------|--|
| NO. | REVISIONS DESCRIPTION | DATE | BY | BENCH MARK ELEV. XXXX | | 1" | CITY OF S | SACRA | AMENTO | |
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| | | | | | H: 1"=100' V: N/A | DRAWING ADJUST SCALED DIMENSIONS IF THIS DOES NOT | | | CHECKED BY: J. PANGBURN | 3301 C St, Bldg. 100-B Sacramento, CA 95816 Tel 916.341.7760 |
| | | | | | V: <u>N/A</u> | SCALE AT 1" | ATE: <u>AUGUST 2025</u> R.C.E. NO. <u>93987</u> | _ DATE: F | R.C.E. NO. <u>71445</u> DATE: | - Fax 916.341.7767 |

IMPROVEMENT PLANS FOR 9TH STREET SEPARATED BIKEWAY TITLE SHEET

| 200 | DWG. NO. TS-1 |
|-------|-------------------------|
| 15245 | SHEET 1 |
| N. | — OF — |
| Ъ | 4 |

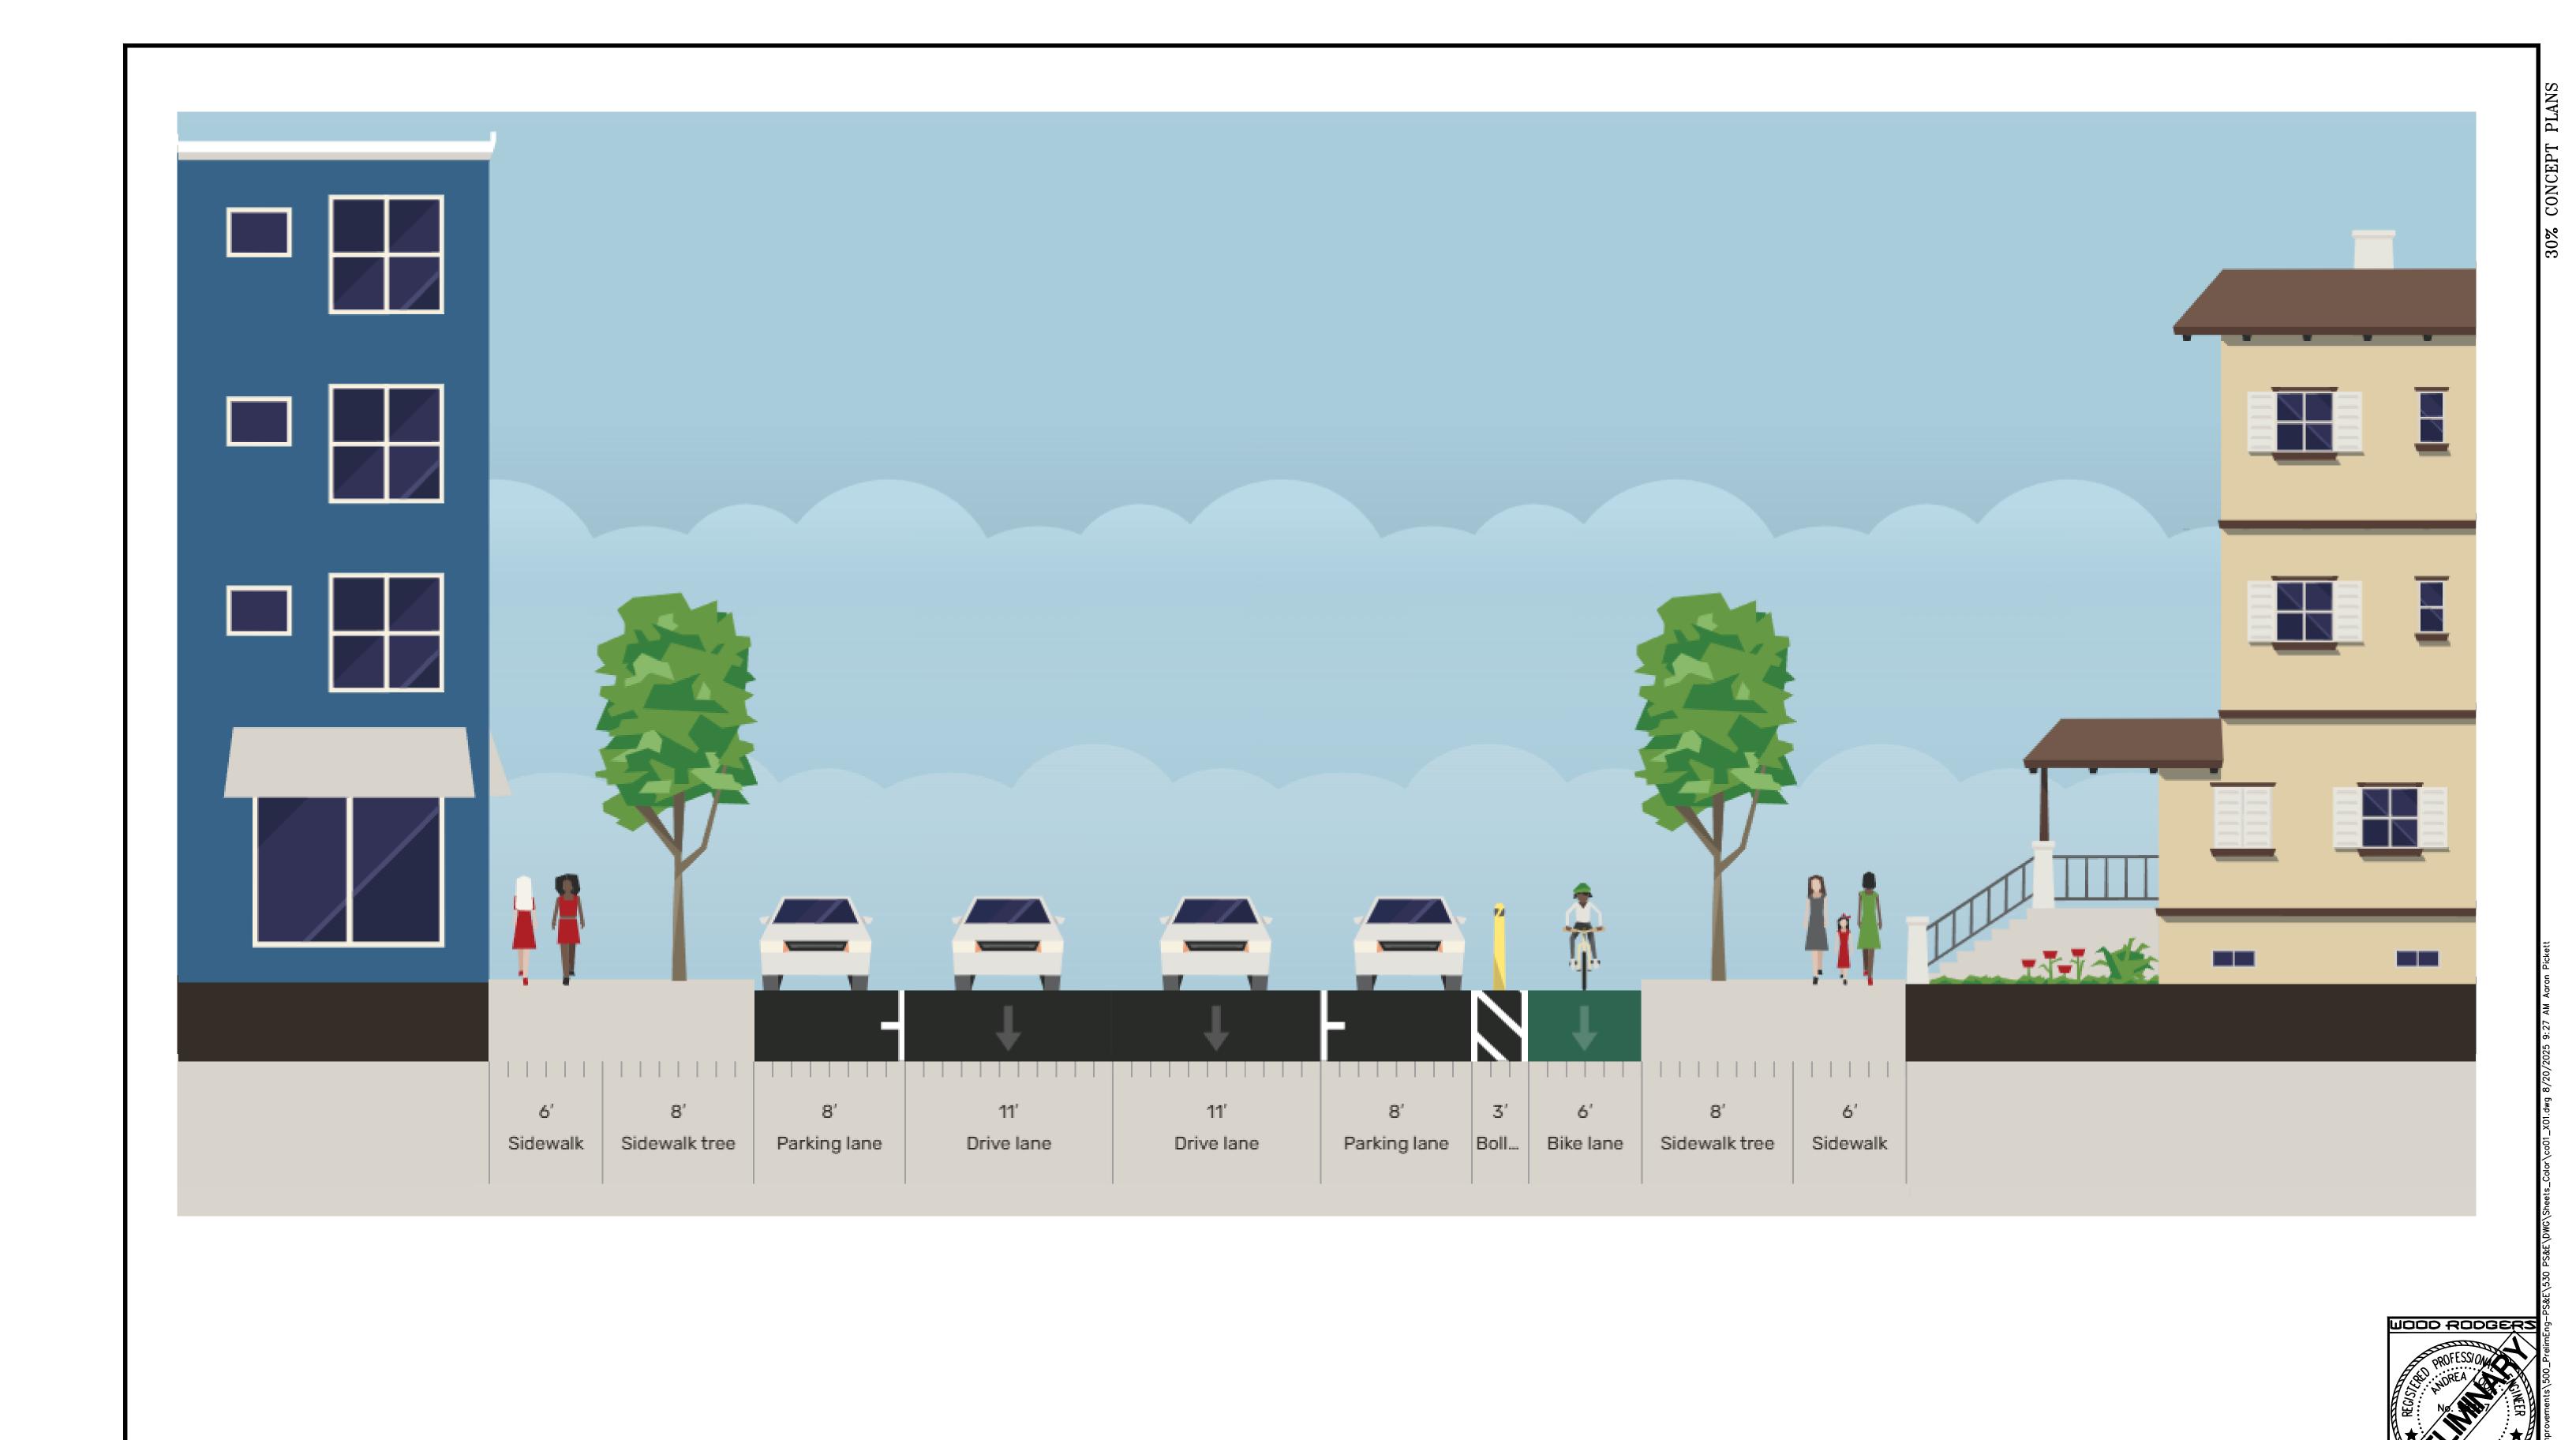

REVISIONS CITY OF SACRAMENTO BENCH MARK ELEV. XXXX DATE BY DESCRIPTION WOOD RODGERS DEPARTMENT OF PUBLIC WORKS DESCRIPTION: SCALE: ON ORIGINAL SCALE DRAWING ADJUST SCALED DIMENSIONS IF THIS DOES NOT SCALE AT 1"

DEPAF

DRAWN BY: A. PICKETT

DATE: AUGUST 2025 BUILDING RELATIONSHIPS ONE PROJECT AT A TIME 3301 C St, Bldg. 100-B Sacramento, CA 95816 Tel 916.341.7760 Fax 916.341.7767 XXXXX DESIGNED BY: A. LOOK CHECKED BY: J. PANGBURN R.C.E. NO. <u>71445</u> DATE: _ R.C.E. NO. <u>93987</u> DATE:

9TH STREET SEPARATED BIKEWAY

CONCEPTUAL CROSS SECTION


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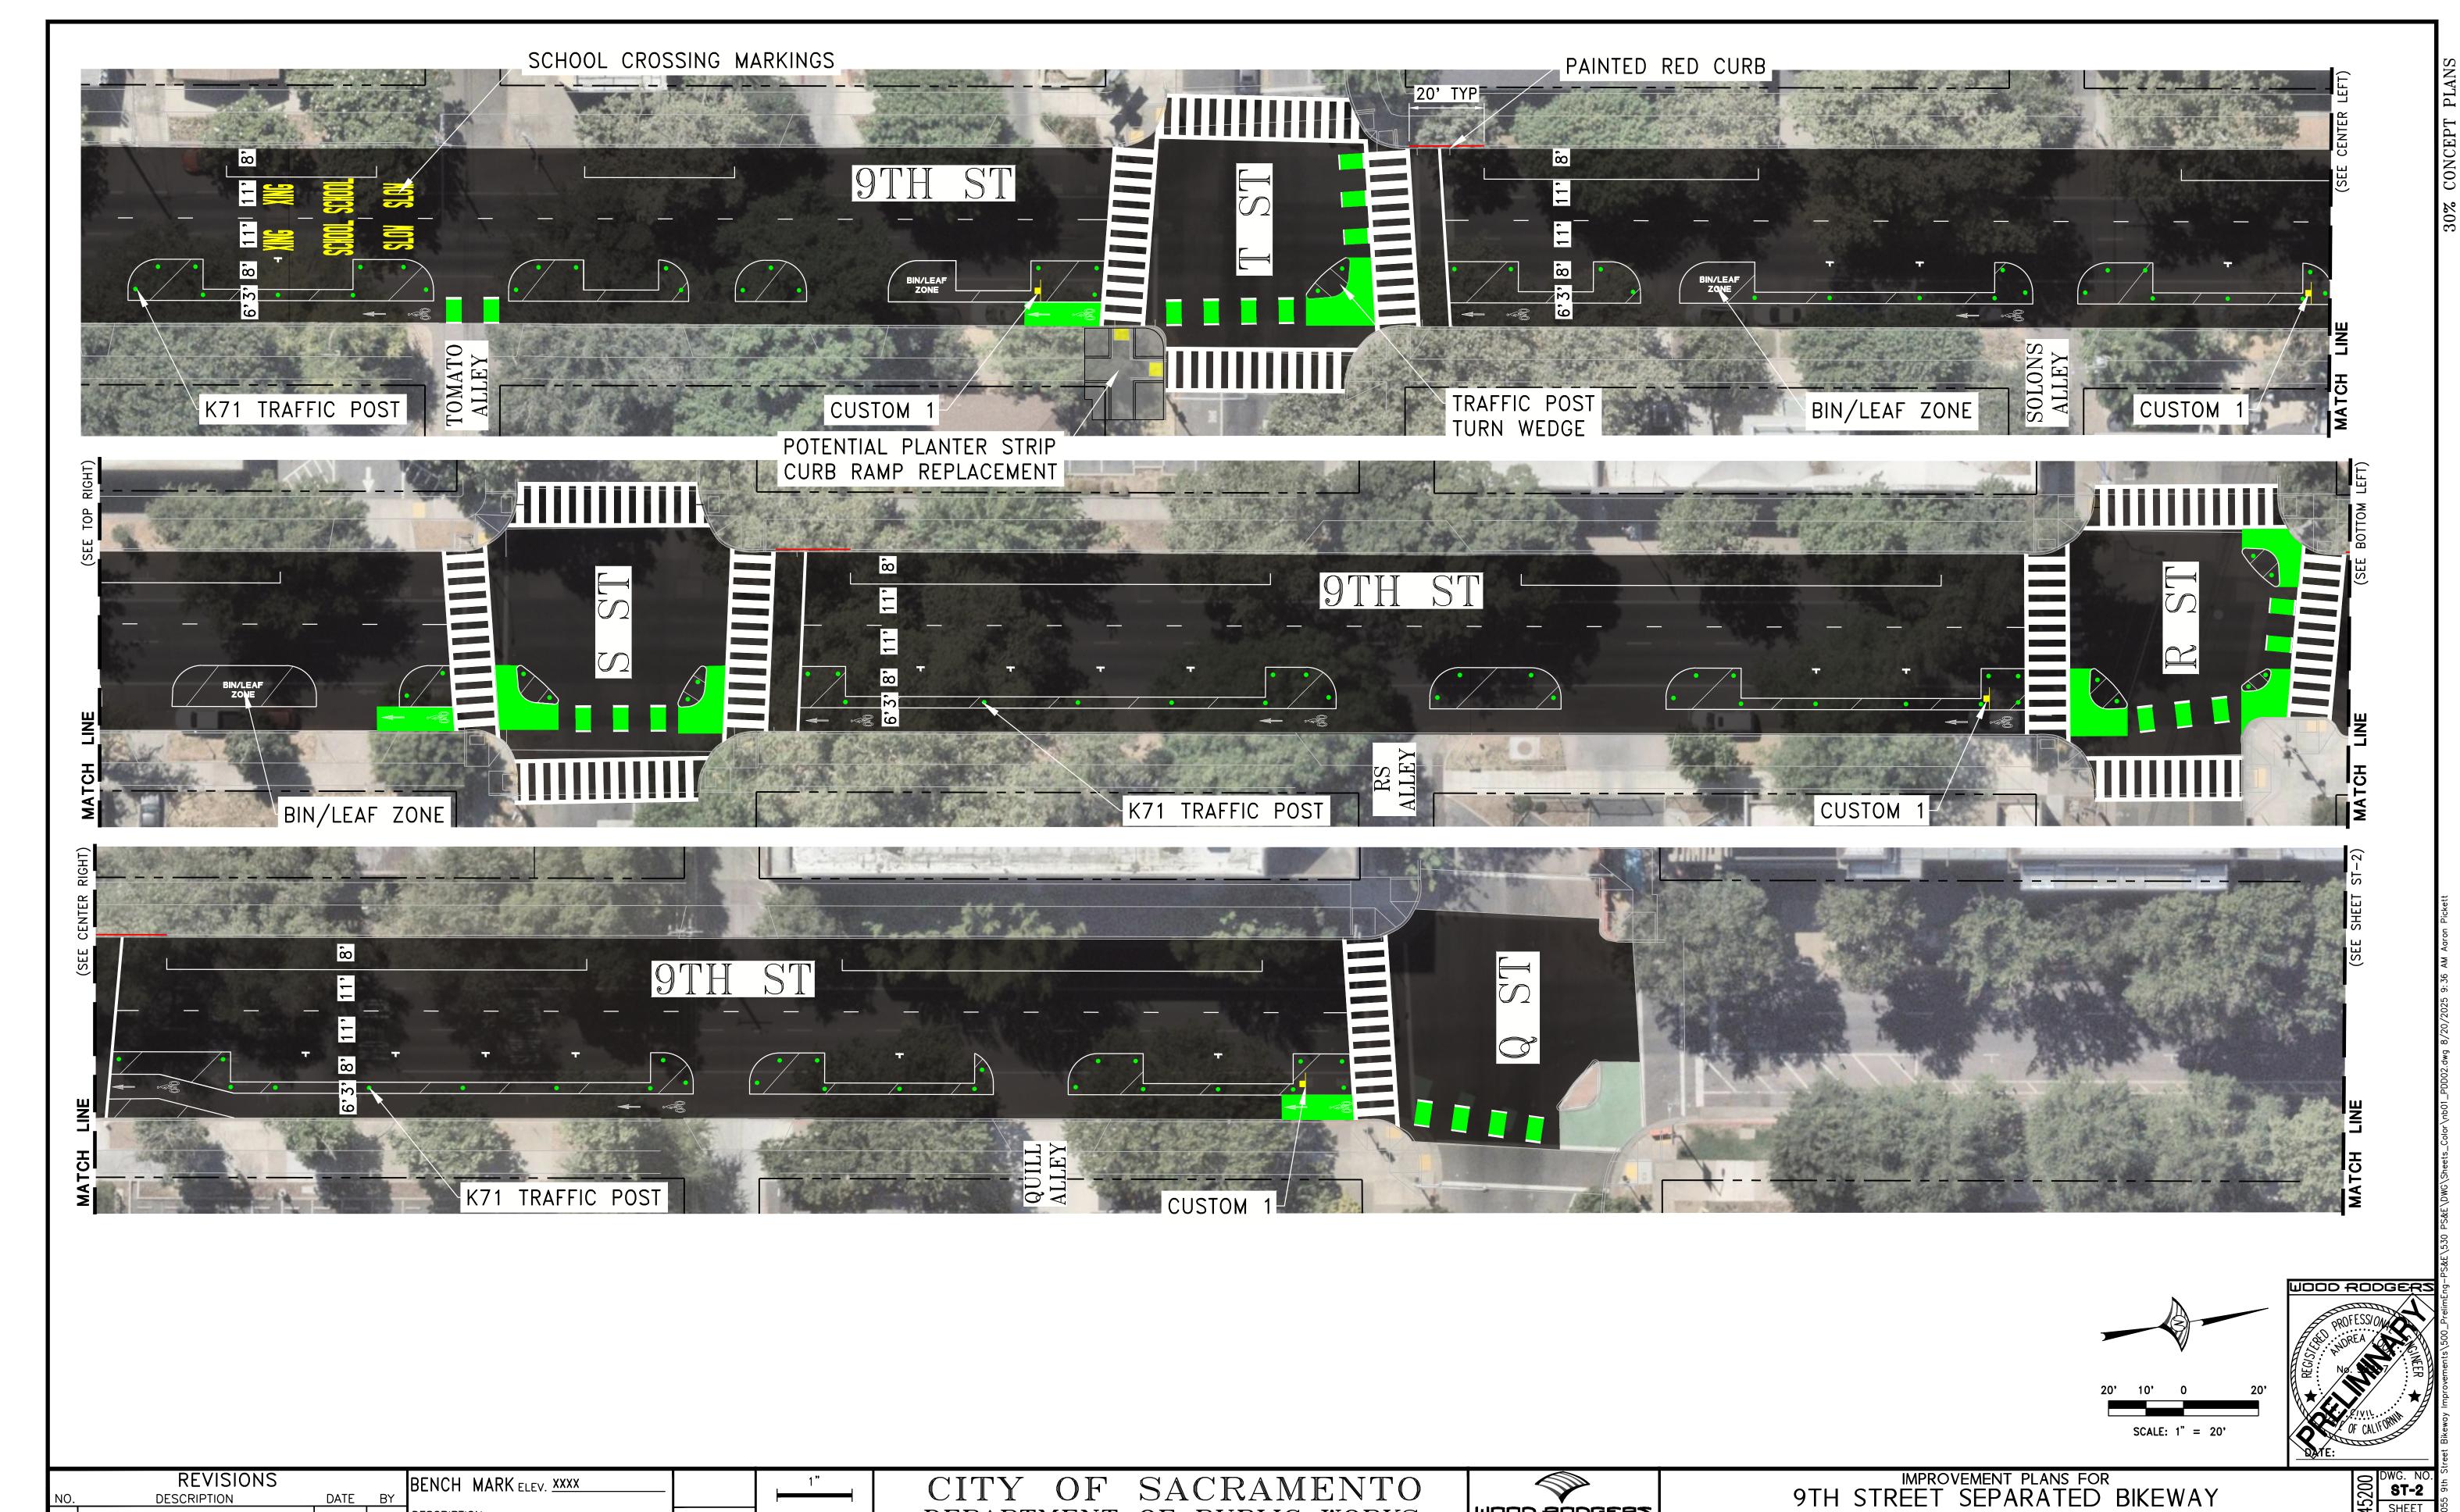
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DEPARTMENT OF PUBLIC WORKS

R.C.E. NO. <u>93987</u> DATE:

CHECKED BY: J. PANGBURN

R.C.E. NO. **71445** DATE: _

WOOD RODGERS

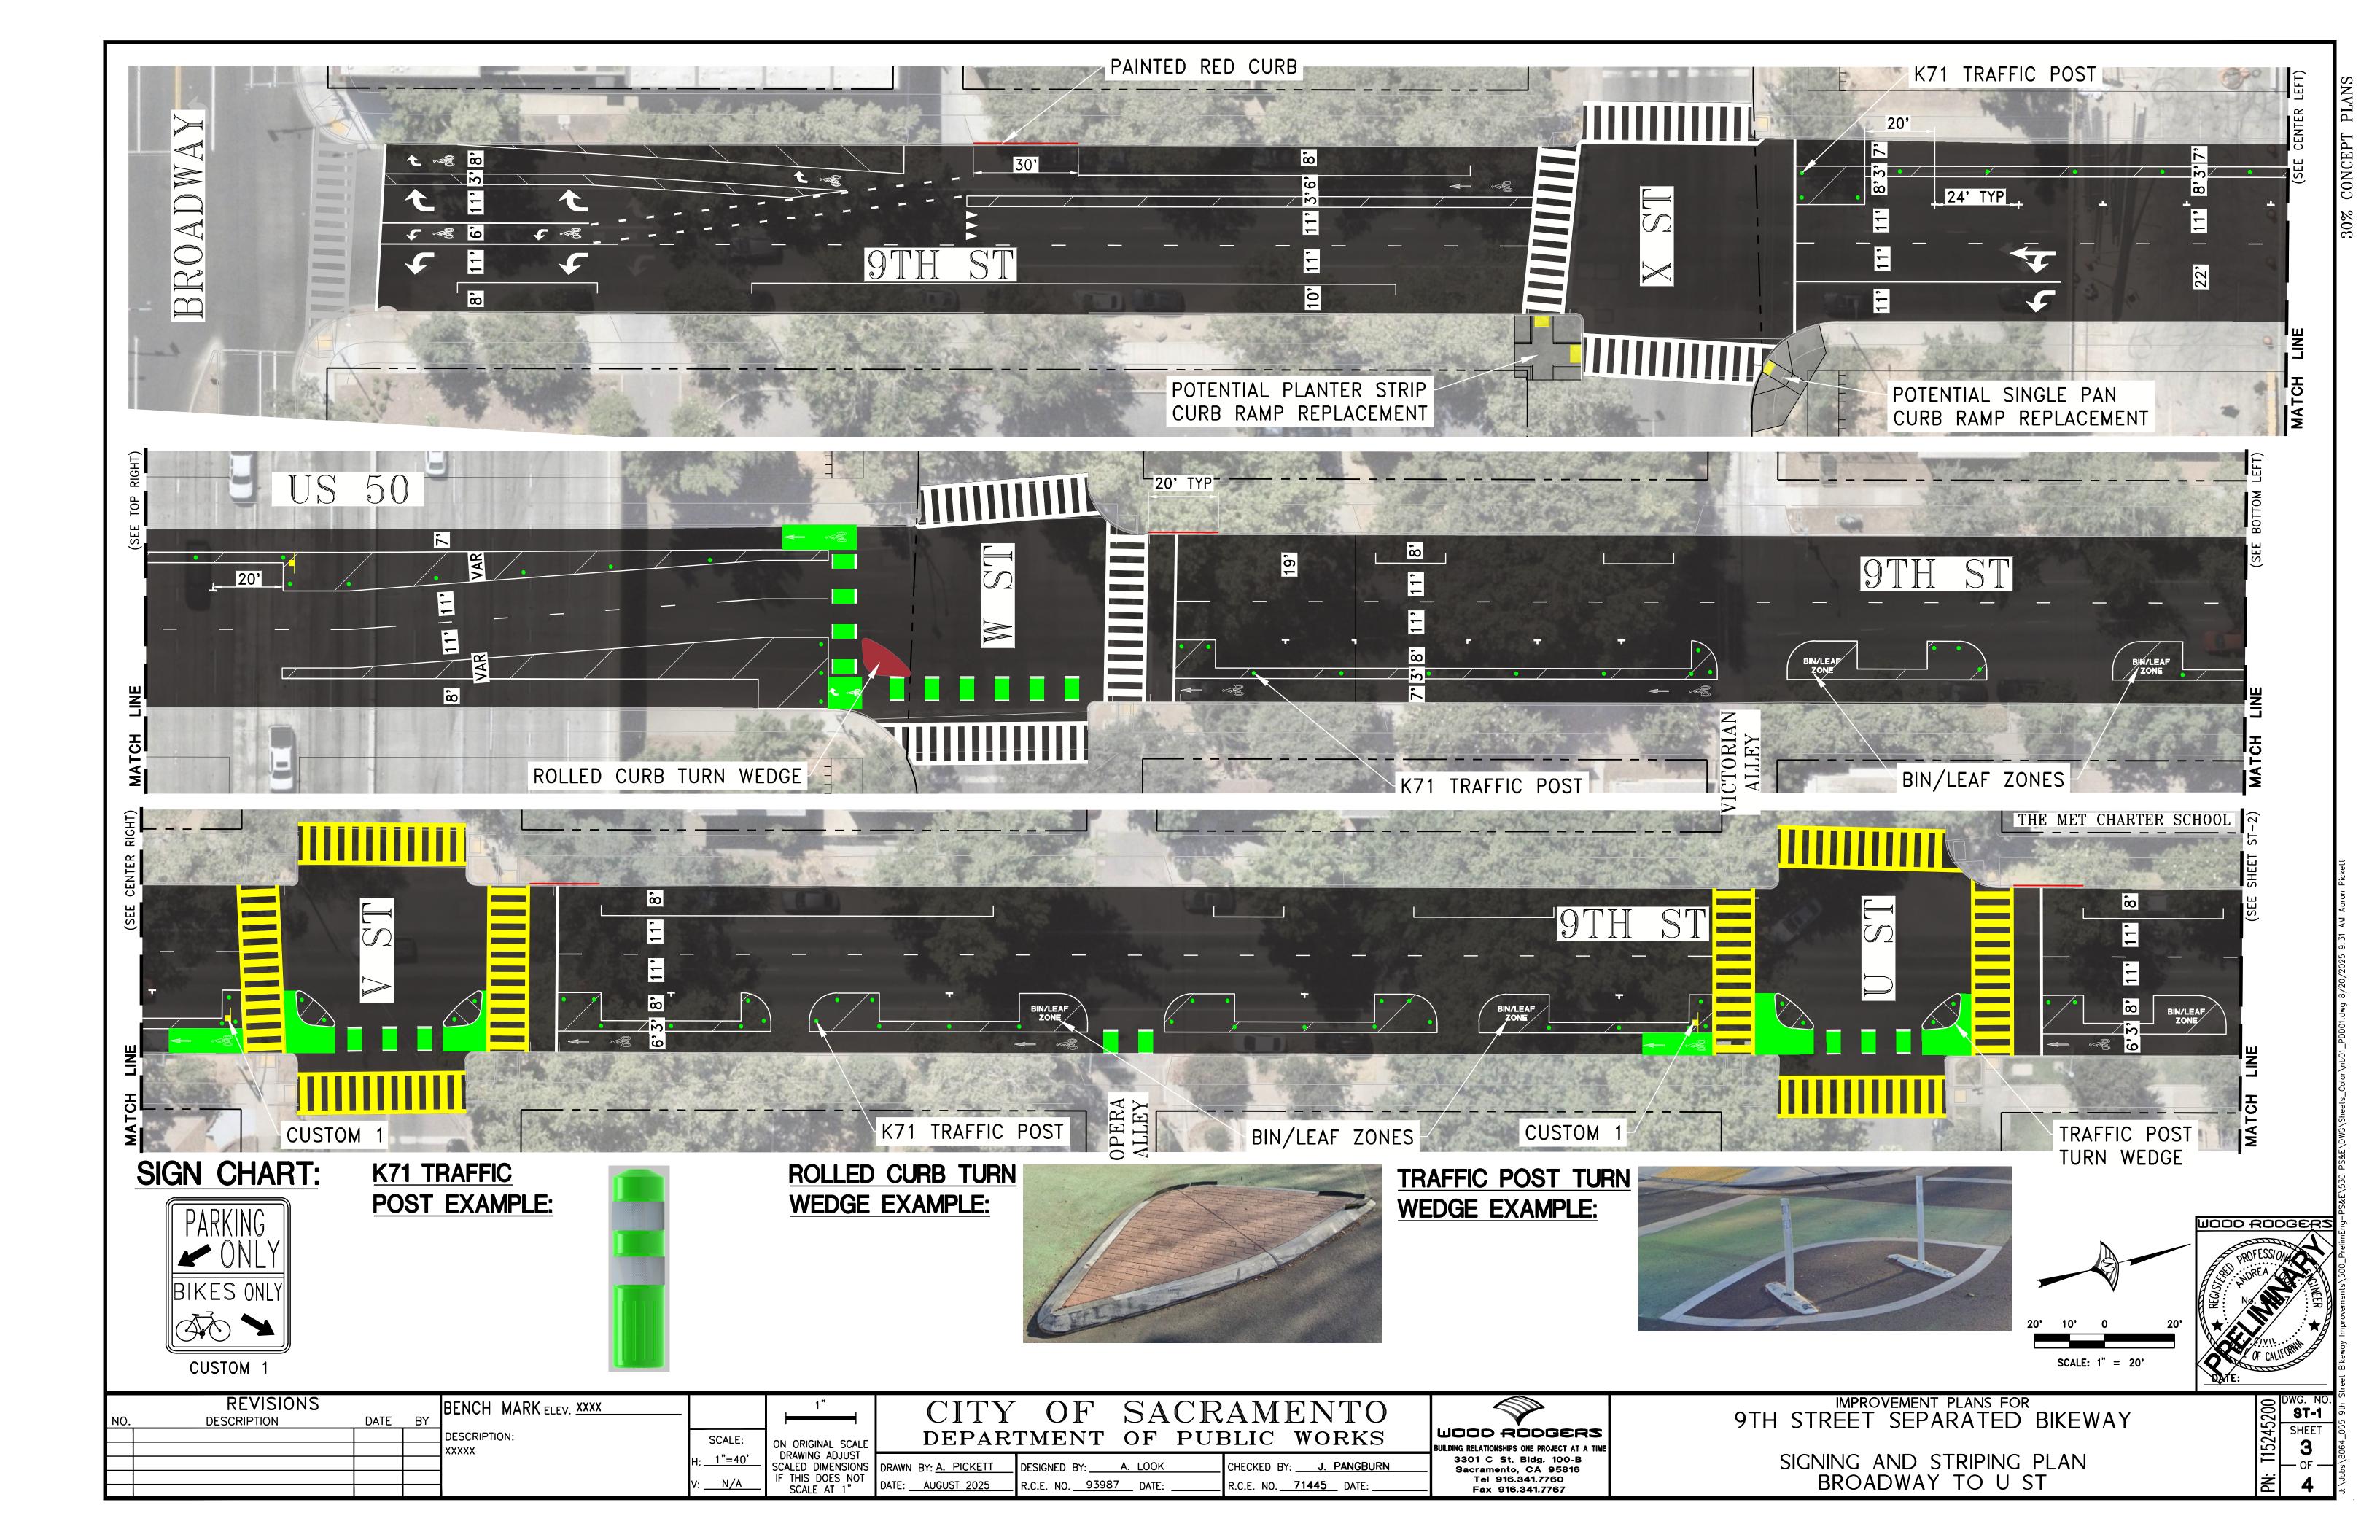3301 C St, Bldg. 100-B Sacramento, CA 95816 Tel 916.341.7760 Fax 916.341.7767

DATE BY

DESCRIPTION:

XXXXX

SCALE:

1"=40'

ON ORIGINAL SCALE DRAWING ADJUST SCALED DIMENSIONS IF THIS DOES NOT SCALE AT 1"

DEPA

DRAWN BY: A. PICKETT
DATE: AUGUST 2025

DESCRIPTION

SIGNING AND STRIPING PLAN U ST TO Q ST



James Kragh Date: 09/18/2025





Purpose, Need, and Funding Sources


- Project goals:
 - Gap closure of our enhanced bikeways network
- Location selection:
 - Bikeway Master Plan
 - Central City Mobility Project
 - Complimentary to 10th Street Separated Bikeway
- Active Transportation Program (State)





Location

- 9th Street from Q St to Broadway
- 0.6 miles
- District 4
- Downtown, Southside Park, and Land Park

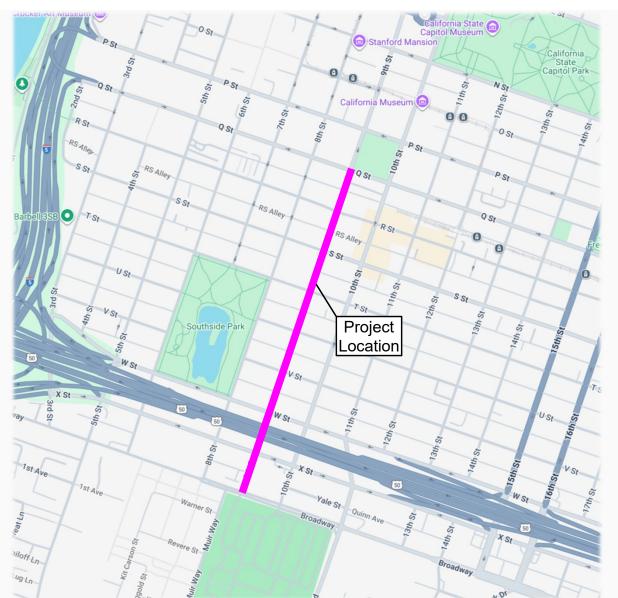



Existing Conditions

- Two southbound vehicle travel lanes
- Two southbound Class II bike lanes
- Classified as One-Way Arterial Road
- 30 MPH speed limit
- Some curb ramps do not meet current ADA standards





Proposed Improvements

Class IV Separated Bikeway (Left side)

Reduce Pedestrian Crossing Exposum

ADA compliant Curb Ramps

Turn Wedges











Project Schedule (Both Projects)



Thank you!

Project manager:

James Kragh

City of Sacramento - Public Works 915 I St Sacramento, CA

jmkragh@cityofsacramento.org (916) 808-6842 SACRAMENTO

